
CONCEPT ENGINEERING PLANS OF 'PROPOSED ANIMAL SHELTER' LOT 100, D.P.602992 OLD MAITLAND ROAD, MARDI

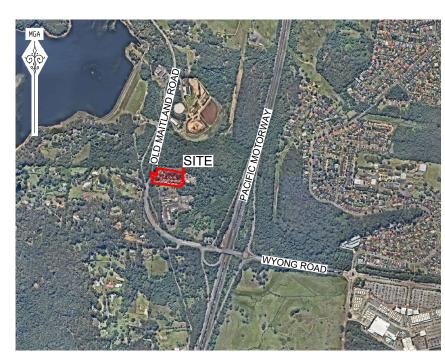

LOCALITY SKETCH

INDEX OF DRAWINGS

| INDEX OF DRAWINGS | | | | | | | | | | |
|-------------------|--|--|--|--|--|--|--|--|--|--|
| DRAWING No. | DRAWING NAME | | | | | | | | | |
| 190872-CENG-00 | 1 COVER SHEET, INDEX OF DRAWINGS & LOCALITY SKETCH | | | | | | | | | |
| 190872-CENG-00 | 2 OVERALL SITE PLAN | | | | | | | | | |
| 190872-CENG-00 | 3 DEMOLITION PLAN | | | | | | | | | |
| 100070 05110 11 | DETAIL BLAN | | | | | | | | | |
| 190872-CENG-10 | 11 DETAIL PLAN | | | | | | | | | |
| 190872-CENG-20 | 1 TYPICAL ROAD CROSS SECTIONS & DETAILS | | | | | | | | | |
| 190872-CENG-2 | | | | | | | | | | |
| 190872-CENG-2 | 2 ROAD LONGITUDINAL SECTION - ROAD 02 | | | | | | | | | |
| | | | | | | | | | | |
| 190872-CENG-40 | 1 STORMWATER DETAIL PLAN | | | | | | | | | |
| | | | | | | | | | | |
| 190872-CENG-50 | 1 SITE REGRADE PLAN | | | | | | | | | |
| 190872-CENG-5 | 1 SITE SECTIONS - SHEET 1 | | | | | | | | | |
| 190872-CENG-5 | 2 SITE SECTIONS - SHEET 2 | | | | | | | | | |
| 400070 OFNO 0 | A FRANCIA A SERIMENT CONTROL BLAN | | | | | | | | | |
| 190872-CENG-60 | | | | | | | | | | |
| 190872-CENG-6 | 1 EROSION & SEDIMENT CONTROL DETAILS | | | | | | | | | |
| 190872-CENG-70 | 1 VEHICLE SWEPT PATH PLAN | | | | | | | | | |
| 100072-02110-71 | VEHICLE SWELLT WITH EAST | | | | | | | | | |
| | 1 | | | | | | | | | |



NOT FOR CONSTRUCTION

PROPERTY DESCRIPTION PROJECT Central Coast PROPOSED ANIMAL SHELTER 5 Pioneer Avenue, LOT 100 D P 602992 NOT TO SCALE P.O. Box 3717, PLAN TITLE Tuggerah N.S.W. 2259 OLD MAITLAND ROAD MARDI COVER SHEET, INDEX OF DRAWINGS Coast Phone: (02) 4305 4300 Fax: (02) 4305 4399 & LOCALITY SKETCH GDA2020 M.G.A. ZONE 56 A.H.D 190872 CENG DESIGN FILE S: \190872\DESIGN\12D\ANIMAL CARE FACILITY.project ALL DIMENSIONS ARE IN METRES. lotted By: Jade Sterrett Plot Date: 05/12/24 10:13:10AM Cad File: S:\190872\DWG\FNGINFFRING\CFNG\190872-CFNG-001.DW

DESIGN FILE S: \190872\DESIGN\12D\ANIMAL CARE FACILITY.project

PROPERTY DESCRIPTION LOT 100, D.P.602992 OLD MAITLAND ROAD, MARDI

PACIFIC MOTORWAY

GDA2020 M.G.A. ZONE 56 A.H.D.

PROJECT PROPOSED ANIMAL SHELTER PLAN TITLE OVERALL SITE PLAN

CENG

190872

12 D.P.558085

OVERALL SITE PLAN
SCALE 1:1000

AMENDMENT

OLD MAITLAND ROAD

SHEET 101 100 D.P.60295

ROAD 01

D.P.1007818

Johnson www.adwjohnson.com.au ABN 62 129 445 398

ALL DIMENSIONS ARE IN METRES. DO NOT SCAL Plotted By: Jade Sterrett Plot Date: 05/12/24 10:13:15AM Cad File: S:\190872\DWG\ENGINEERING\CENG\190872-CENG-002.DWG


LEGEND


SITE BOUNDARY
EXISTING LOT BOUNDARY
PROPOSED KERB
EXISTING KERB


NOT FOR CONSTRUCTION

NUMBER 002


FEV.

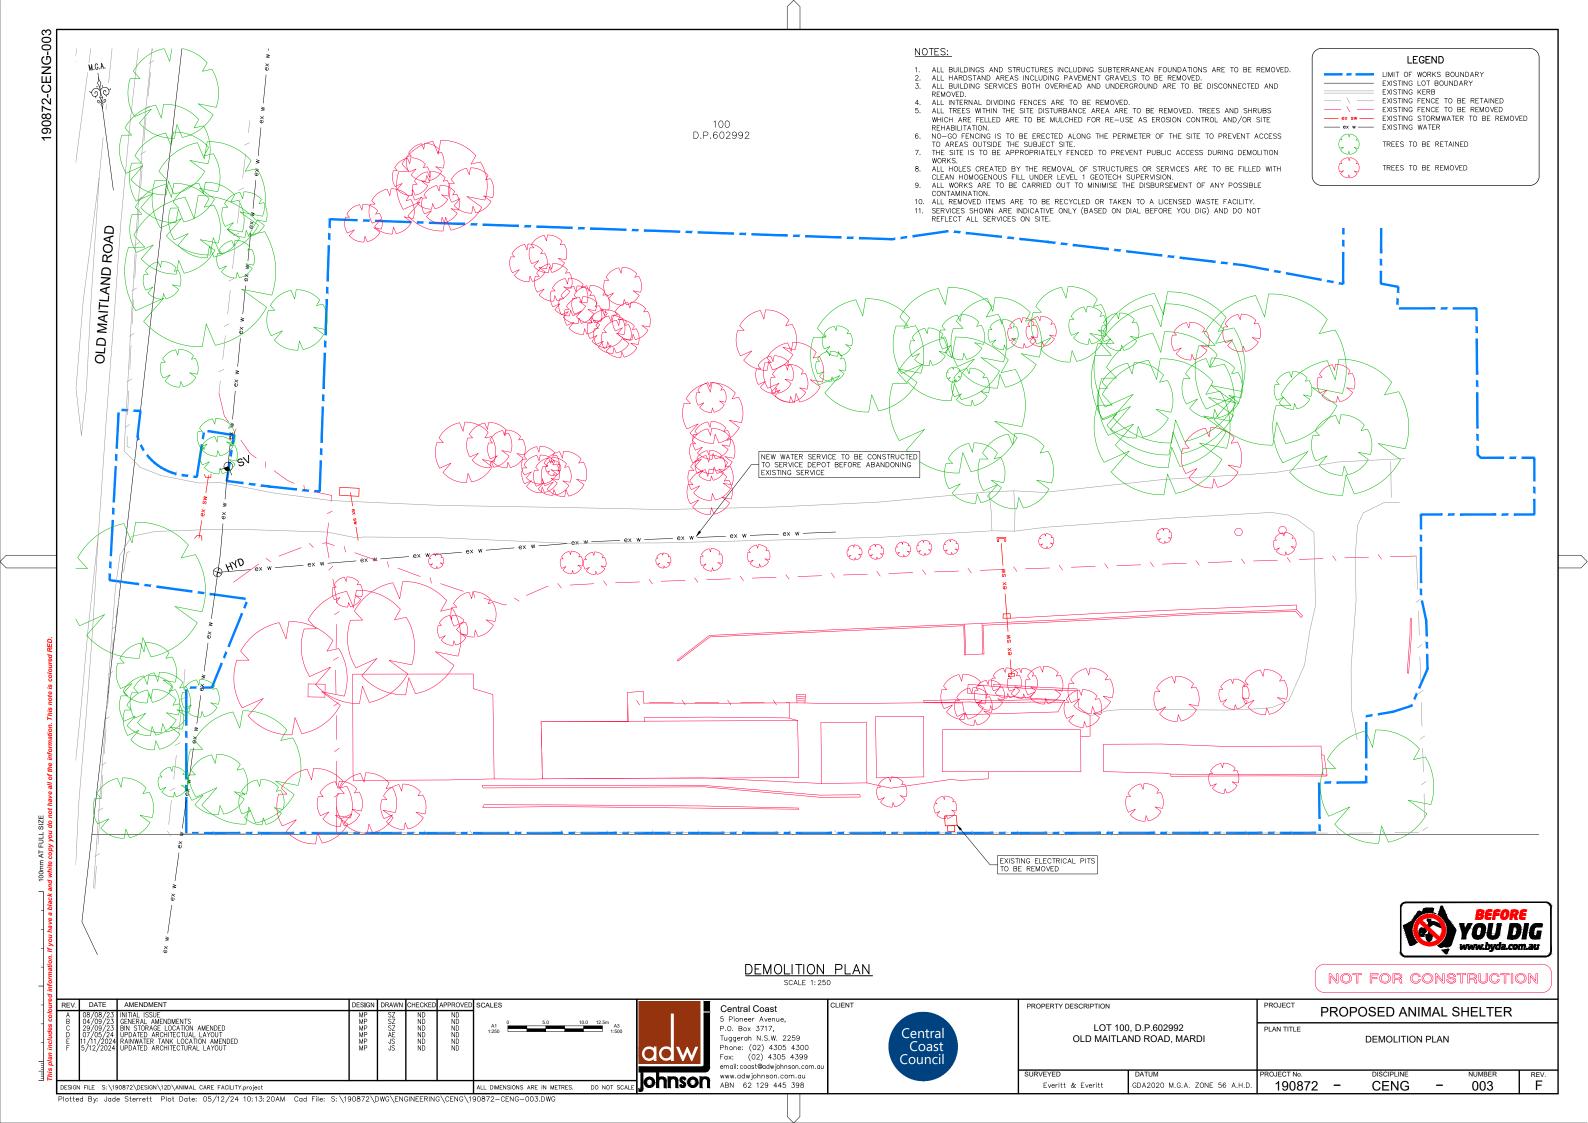

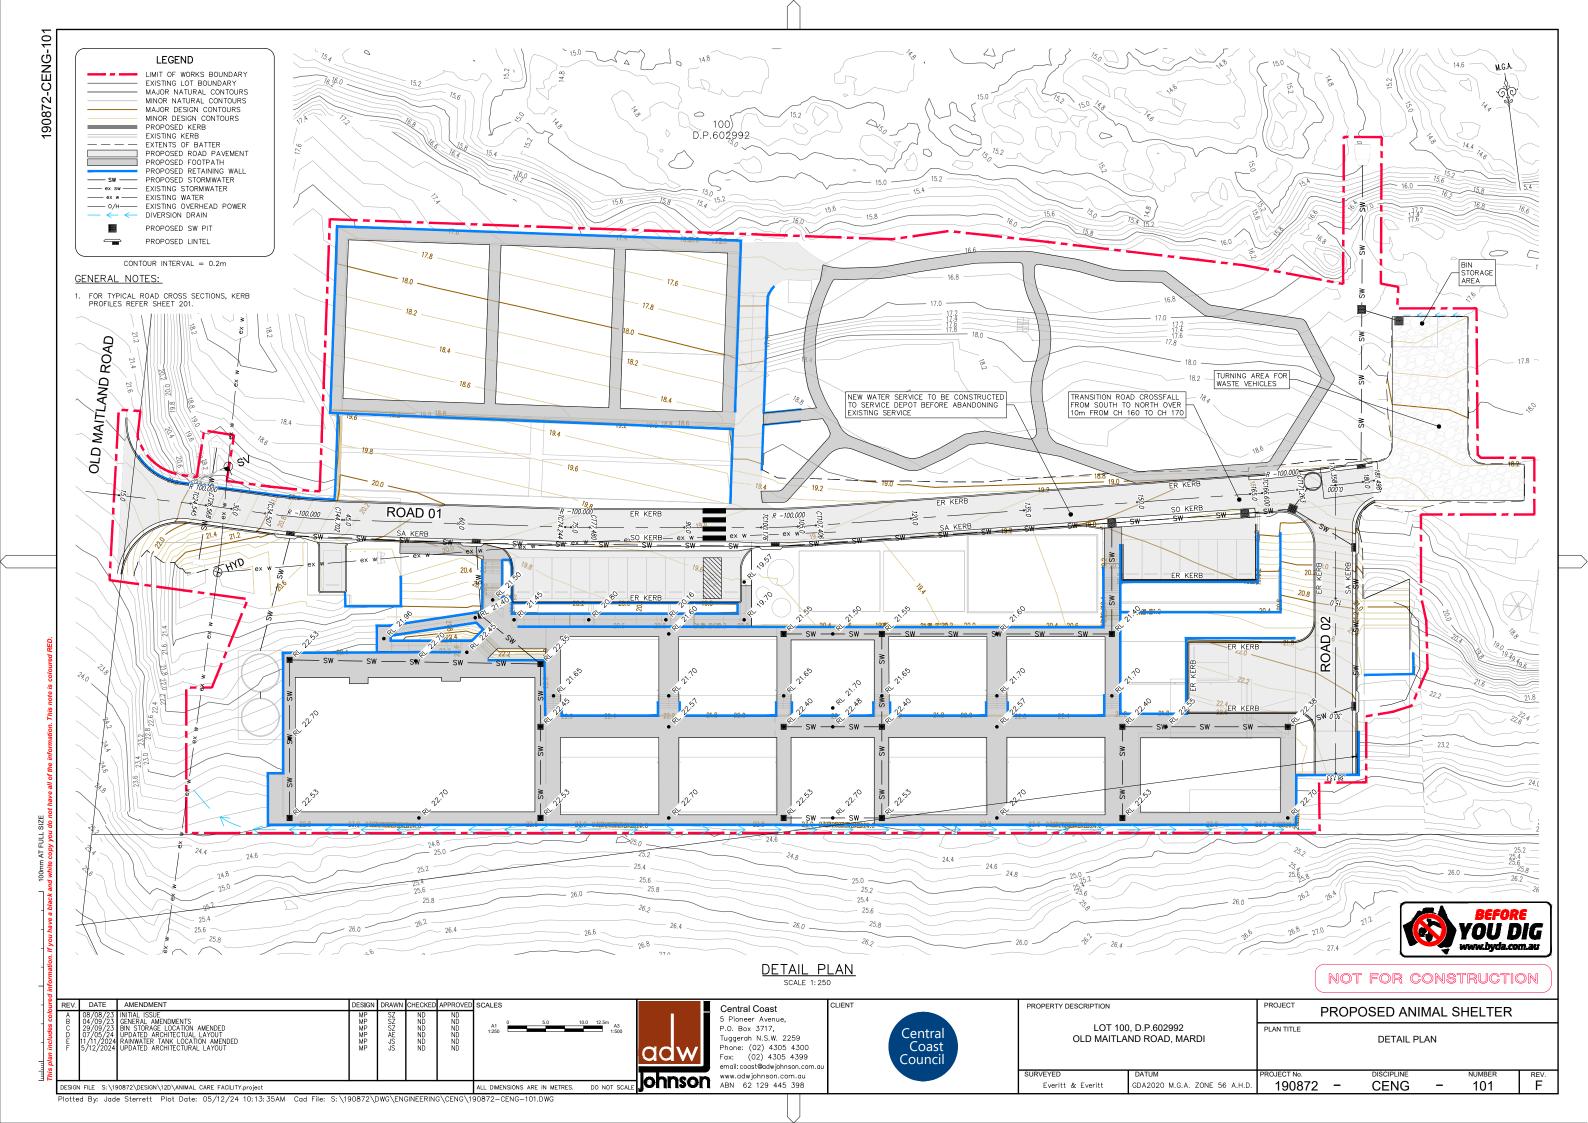


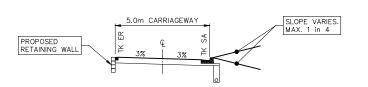


TYPICAL ROAD SECTION - ROAD 01 START TO CH 63 SCALE 1 : 100

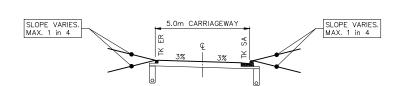


TYPICAL ROAD SECTION - ROAD 01 CH 97 TO CH 143

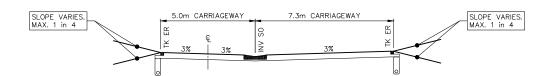

TYPICAL ROAD SECTION - ROAD 01 CH 67 TO CH 96 & CH 148 TO CH 165 SCALE 1: 100

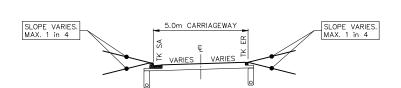


TYPICAL ROAD SECTION - ROAD 01 CH 165 TO CH 170

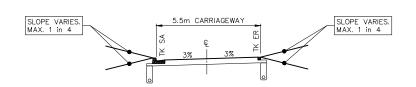

TYPICAL ROAD SECTION - ROAD 02 START TO END SCALE 1: 100

300mm PROPOSED NEW PAVEMENT EXISTING PAVEMENT 300mm - ASPHALT WITH PRIMER SEAL GRAVEL PAVEMENT (BASE COURSE) - GRAVEL PAVEMENT (SUB-BASE COURSE)

TYPICAL SAWCUT DETAIL SCALE 1: 10

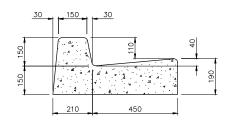

BARRIER KERB & CHANNEL

(MODIFIED SA KERB) SCALE 1: 10



EDGE RESTRAINT SCALE 1: 10


1200 600


SHOULDER CHANNEL


(MODIFIED SO KERB) SCALE 1 : 10



NOT FOR CONSTRUCTION

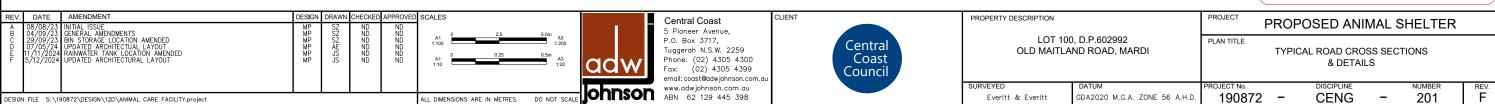

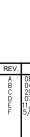


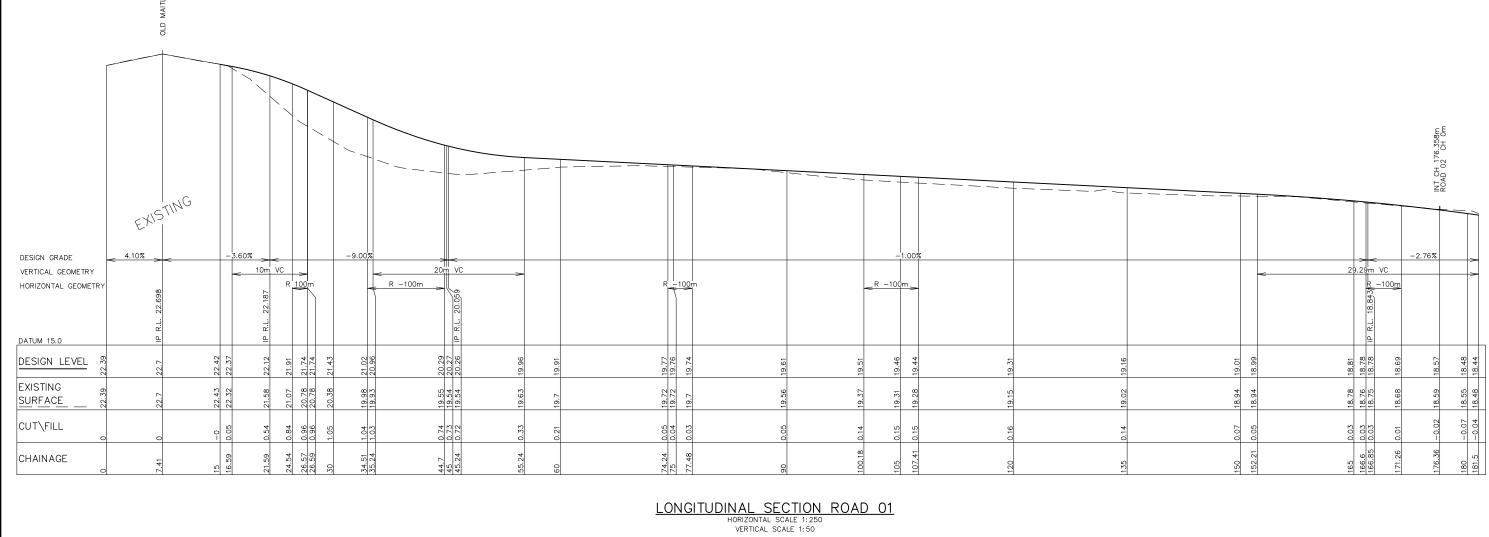



NOT FOR CONSTRUCTION

| REV. | DATE AMENDMENT 08/08/23 INITIAL ISSUE | DESIGN MP | DRAW | ND ND | APPROVED ND | SCALES | Central Coast 5 Pioneer Avenue, CLIENT PROPERTY DESCRIPTION | | | PROPOSED ANIMAL SHELTER | | | | | | |
|--|--|--------------|-------------------------------|----------------------|----------------------|---|--|-------------------|--|-----------------------------|---|-------|-------------|------------------------------|--------|------|
| BCDEF | 04/09/32 29/09/32 07/05/24 UPDATED ARCHITECTUAL LAYOUT 11/11/2024 UPDATED ARCHITECTUAL AQUITON 5/12/2024 UPDATED ARCHITECTURAL LAYOUT | MP MP MP MP | SZ SZ AE JS JS | ND ND ND ND | ND ND ND ND | A1 0 5.0 1.250 A1 1:50 | 10.0 12.5m A3 1:500 2.5 m A3 1:100 | adw | P.O. Box 3717, Tuggerah N.S.W. 2259 Phone: (02) 4305 4300 Fax: (02) 4305 4399 email: coast@adwjohnson.com.au | Central Coast Council | LOT 100, D.P.602992 OLD MAITLAND ROAD, MARDI | | PLAN TITLE | ROAD LONGITUDINAL ROAD 01 | | |
| | | | | | 1 ' | | | labraan | www.adwjohnson.com.au | | SURVEYED | DATUM | PROJECT No. | DISCIPLINE | NUMBER | REV. |
| DESIGN FILE S: \190872\DESIGN\12D\ANIMAL CARE FACILITY.project ALL | | | ALL DIMENSIONS ARE IN METRES. | DO NOT SCALE | TOLILIZOLI | www.adwjohnson.com.au ABN 62 129 445 398 | | Everitt & Everitt | GDA2020 M.G.A. ZONE 56 A.H.D. | 190872 | CENG | - 211 | F | | | |

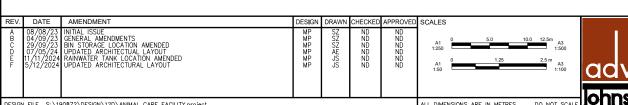

adw

DESIGN GRADE VERTICAL GEOMETRY HORIZONTAL GEOMETRY

DATUM 15.0 DESIGN LEVEL EXISTING SURFACE

CUT\FILL

CHAINAGE

Central Coast
5 Pioneer Avenue,
P.O. Box 3717,
Tuggerah N.S.W. 2259
Phone: (02) 4305 4300
Fox: (02) 4305 4399
email: coast@adwjohnson.com CLIENT

LONGITUDINAL SECTION ROAD 02

HORIZONTAL SCALE 1:250
VERTICAL SCALE 1:50



1.00% _

-1.35

PROPERTY DESCRIPTION LOT 100, D.P.602992 OLD MAITLAND ROAD, MARDI

GDA2020 M.G.A. ZONE 56 A.H.D.

Everitt & Everitt

NOT FOR CONSTRUCTION PROJECT PROPOSED ANIMAL SHELTER

CENG

REV.

212


PLAN TITLE ROAD LONGITUDINAL SECTION ROAD 02


190872


DESIGN FILE S: \190872\DESIGN\12D\ANIMAL CARE FACILITY.project

www.adwjohnson.com.au
ABN 62 129 445 398 ALL DIMENSIONS ARE IN METRES. DO NOT SCALE

Plotted By: Jade Sterrett Plot Date: 05/12/24 10:13:48AM Cad File: S:\190872\DWG\ENGINEERING\CENG\190872-CENG-212.DWG

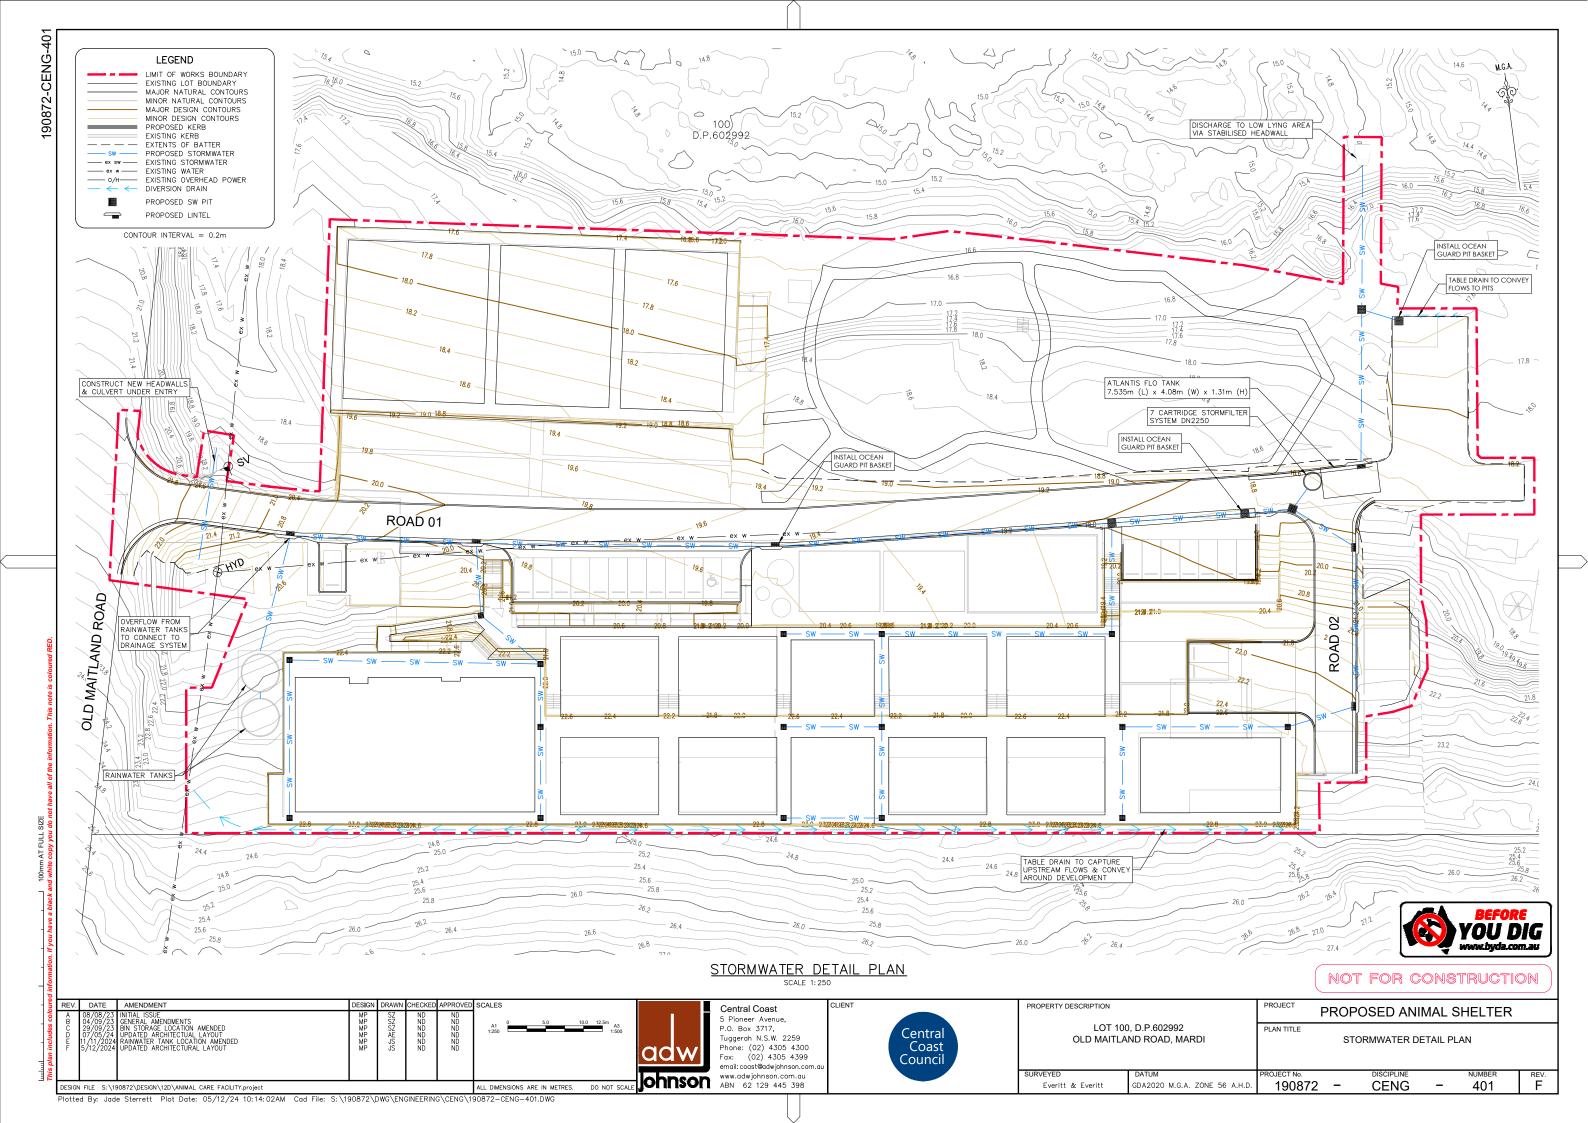

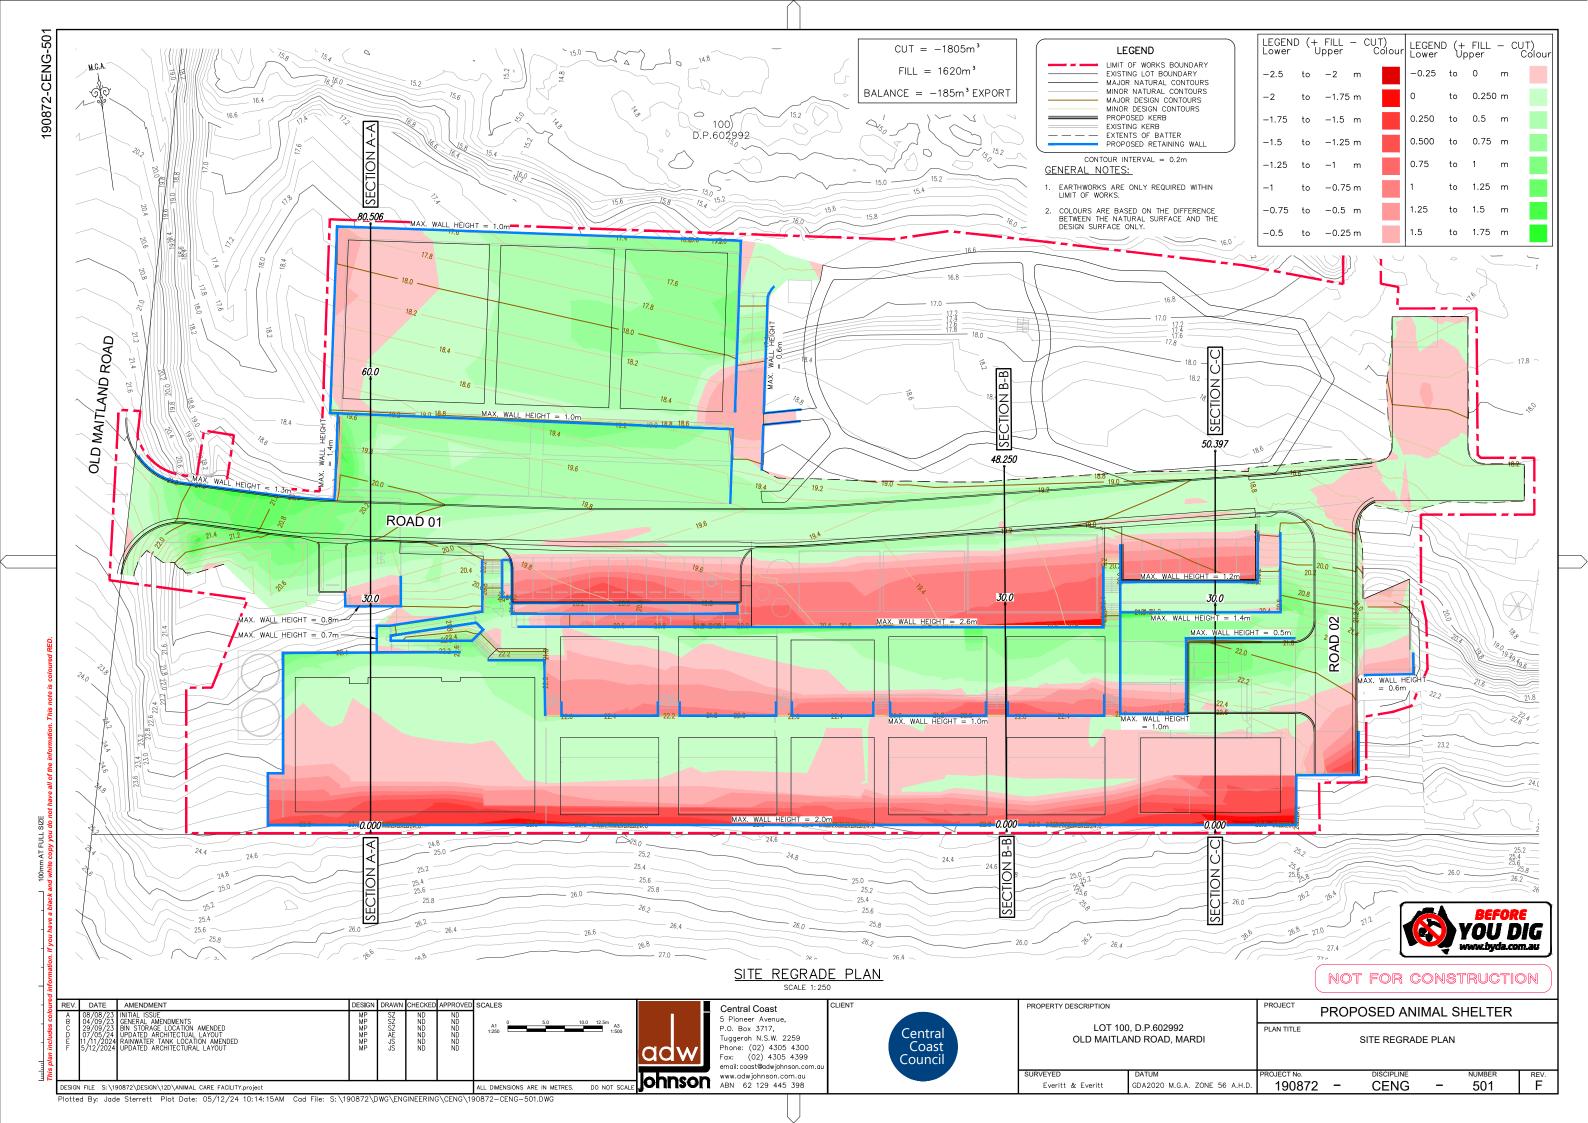

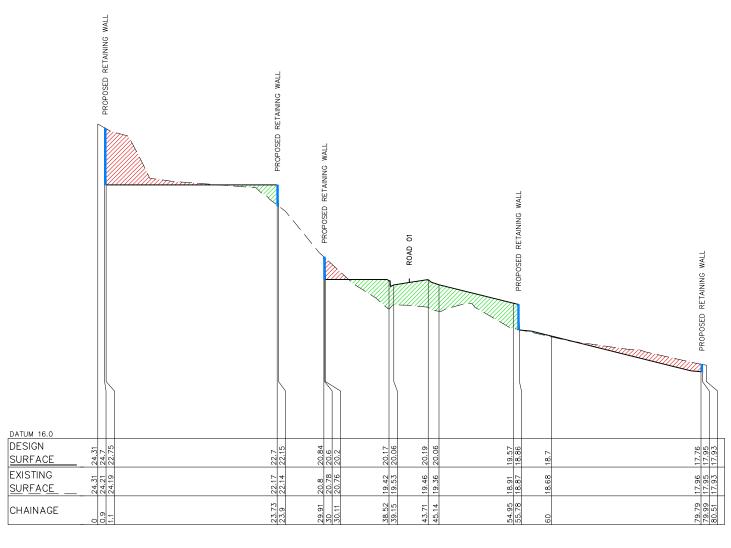

SITE SECTION A-A

HORIZONTAL SCALE 1:250
VERTICAL SCALE 1:50

GENERAL NOTES

- CUT/FILL VALUES SHOWN ARE INDICATIVE ONLY AND REPRESENTATIVE OF LEVEL DIFFERENCE BETWEEN EXISTING SURFACE AND PROPOSED FINISHED SURFACE ONLY.
- 2. NO ALLOWANCE HAS BEEN MADE FOR STRIPPING/GRUBBING, PAVEMENT BOXING, OVER EXCAVATION FOR BUILDINGS, BULKING FACTORS ETC.




NOT FOR CONSTRUCTION


| coloure | REV. A 08 B 04 | DATE 8/08/23 | AMENDMENT INITIAL ISSUE CENERAL AMENINATIS | DESIGN MP | DRAWN CHECK | KED APPROVE ND | SCALES | 400 425- | | Central Coast 5 Pioneer Avenue. | CLIENT | PROPERTY DESCRIPTION | | PROPOSED ANIMAL SHELTER | | | |
|---|-----------------------|--------------------------------|---|---|-----------------------|----------------------|---|-------------------|-------------------------------|--|-----------------------------|----------------------|---|-------------------------|--------------------------|--------|------|
| plan includes | C 29 D 07 E 11/ | 7/09/23 7/05/24 /11/2024 | BIN STORAGE LOCATION AMENDED UPDATED ARCHITECTUAL LAYOUT RAINWATER TANK LOCATION AMENDED UPDATED ARCHITECTURAL LAYOUT | TED ARCHITECTUAL LAYOUT MP AE ND ND WATER TANK LOCATION AMENDED MP JS ND ND | | ND ND ND ND | A1 1250 3.0 10.0 12.5m A3 1:500 A1 1:500 12.5m A3 1:100 | | adw | P.O. Box 3717, Tuggerah N.S.W. 2259 Phone: (02) 4305 4300 Fax: (02) 4305 4399 email: coast@odwiohnson.com.au | Central Coast Council | | LOT 100, D.P.602992 OLD MAITLAND ROAD, MARDI | | SITE SECTIONS SHEET 1 | | |
| 1 2 | | | | | | - 1 | | | la bracer | www.adwjohnson.com.au | | SURVEYED | DATUM | PROJECT No. | DISCIPLINE | NUMBER | REV. |
| DESIGN FILE S:\190872\DESIGN\12D\ANIMAL CARE FACILITY.project | | | ALL DIMENSIONS ARE IN METRES. | DO NOT SCALE | 1101 IL 1201 . | ABN 62 129 445 398 | | Everitt & Everitt | GDA2020 M.G.A. ZONE 56 A.H.D. | 190872 - | CENG - | 511 | F | | | | |

adw

FILL

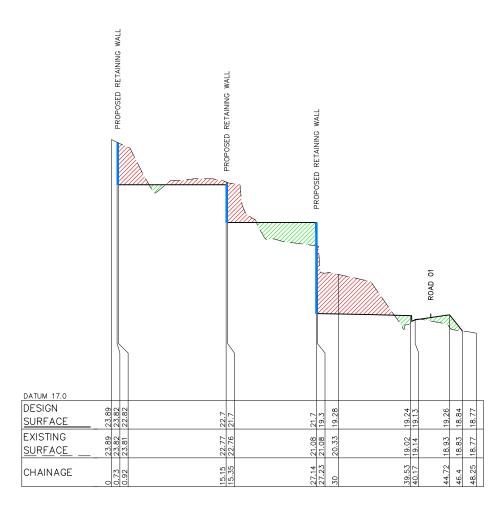

SITE SECTION B-B
HORIZONTAL SCALE 1:250 VERTICAL SCALE 1:50

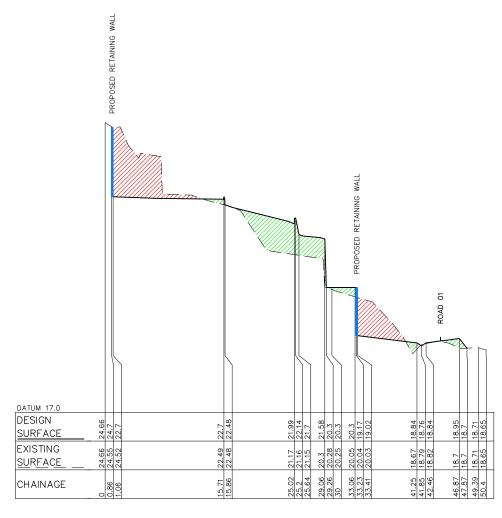


SITE SECTION C-C VERTICAL SCALE 1:50

GENERAL NOTES

- CUT/FILL VALUES SHOWN ARE INDICATIVE ONLY AND REPRESENTATIVE OF LEVEL DIFFERENCE BETWEEN EXISTING SURFACE AND PROPOSED FINISHED SURFACE ONLY.
- 2. NO ALLOWANCE HAS BEEN MADE FOR STRIPPING/GRUBBING, PAVEMENT BOXING, OVER EXCAVATION FOR BUILDINGS, BULKING FACTORS ETC.

NOT FOR CONSTRUCTION

REV. DATE AMENDMENT Central Coast
5 Pioneer Avenue, CLIENT PROPERTY DESCRIPTION PROJECT AMENDMENT
INITIAL ISSUE
GENERAL AMENDMENTS
BIN STORAGE LOCATION AMENDED
UPDATED ARCHITECTUAL LAYOUT
RAINWATER TANK LOCATION AMENDED
UPDATED ARCHITECTURAL LAYOUT PROPOSED ANIMAL SHELTER P.O. Box 3717, Tuggerah N.S.W. 2259 LOT 100, D.P.602992 Central Coast Council PLAN TITLE OLD MAITLAND ROAD, MARDI SITE SECTIONS Phone: (02) 4305 4300 Fax: (02) 4305 4399 SHEET 2 email: coast@adwjohnson.com Johnson www.adwjohnson.com.au ABN 62 129 445 398 REV. GDA2020 M.G.A. ZONE 56 A.H.D. 190872 CENG 512 DESIGN FILE S: \190872\DESIGN\12D\ANIMAL CARE FACILITY.project ALL DIMENSIONS ARE IN METRES. DO NOT SCAL

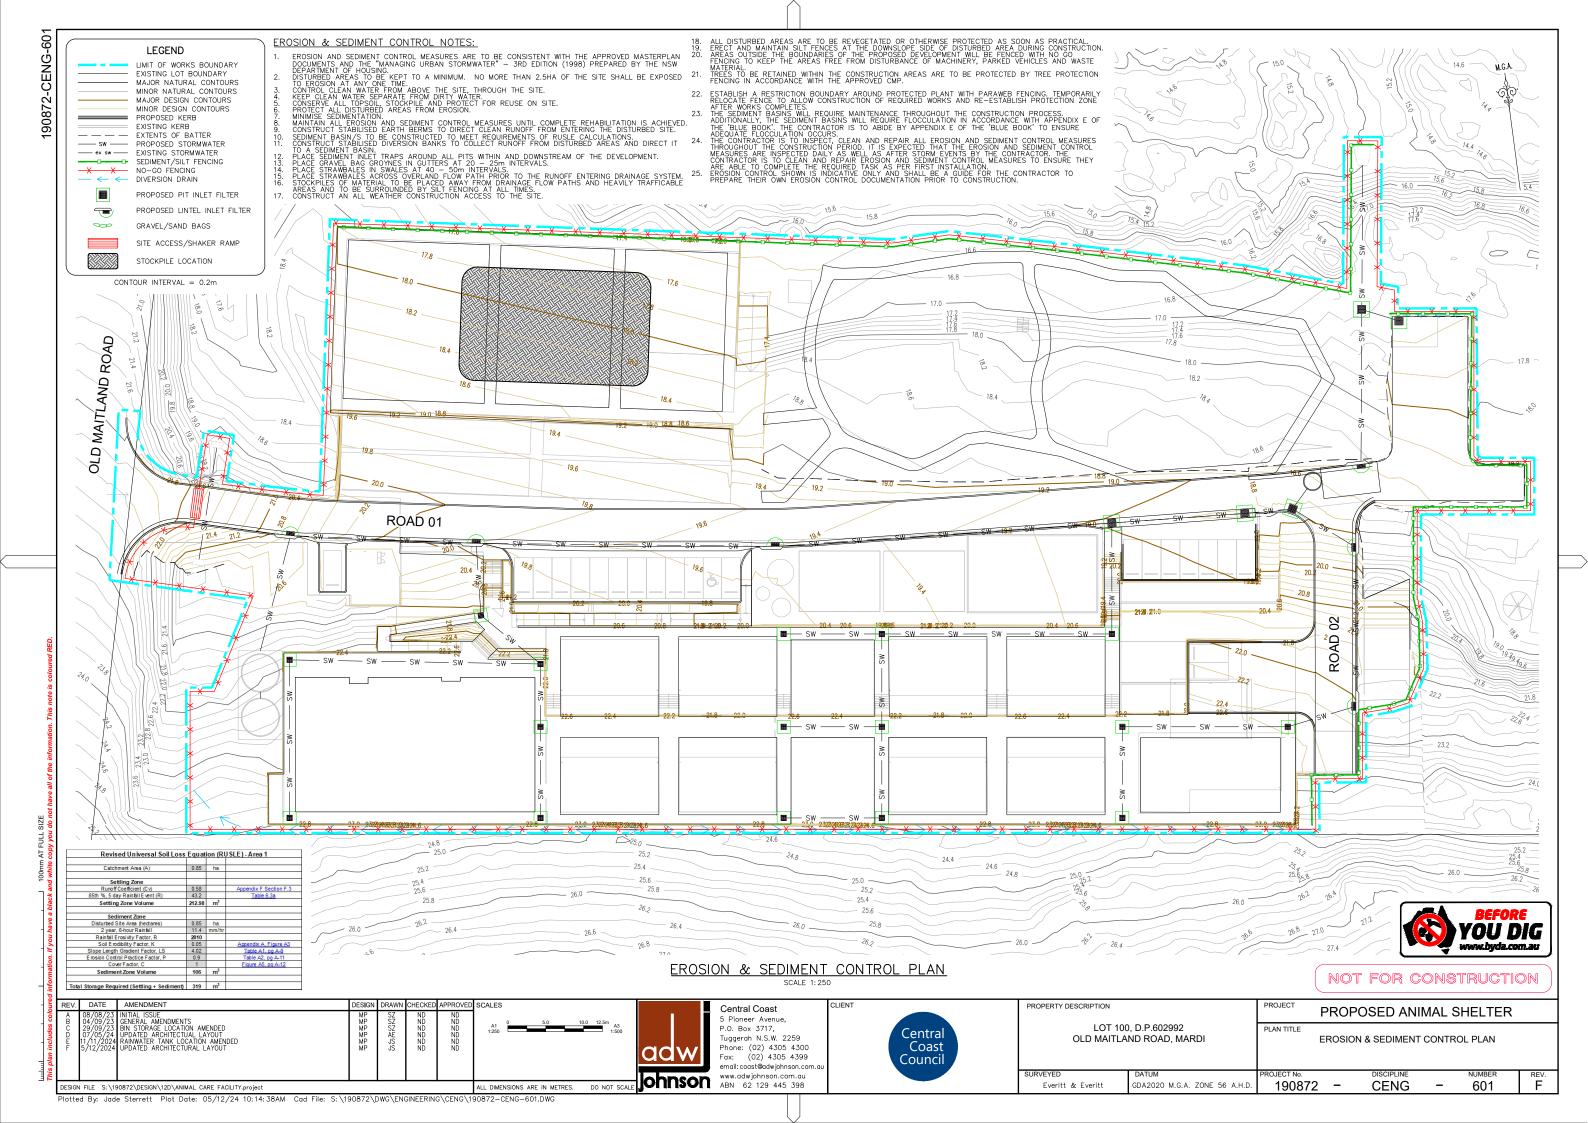


N.T.S. CONSTRUCTION NOTES:

1. PLACE STOCKPILES MORE THAN 2 (PREFERABLY 5) METRES FROM EXISTING VEGETATION, CONCENTRATED WATER FLOW, ROADS AND HAZARD AREAS.

STOCKPILES (SD4-1)


STABILISE STOCKPILE SURFACE

- 2. CONSTRUCT ON THE CONTOUR AS LOW, FLAT, ELONGATED MOUNDS.
- WHERE THERE IS SUFFICIENT AREA, TOPSOIL STOCKPILES SHALL BE LESS THAN 2 METRES IN HEIGHT
- WHERE THEY ARE TO BE IN PLACE FOR MORE THAN 10 DAYS, STABILISE FOLLOWING THE APPROVED ESCP OR SWMP TO REDUCE THE C-FACTOR TO LESS THAN 0.10.
- CONSTRUCT EARTH BANKS (STANDARD DRAWING 5-5) ON THE UPSLOPE SIDE TO DIVERT WATER AROUND STOCKPILES AND SEDIMENT FENCES (STANDARD DRAWING 6-8) 1 TO 2 METRES DOWNSLOPE.

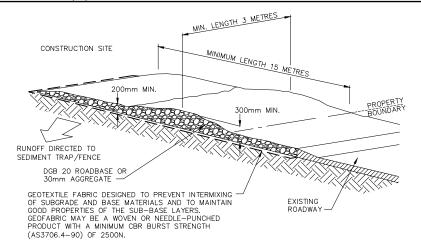


STABILISED SITE ACCESS (SD6-14)


- CONSTRUCTION NOTES:
 1. STRIP THE TOPSOIL, LEVEL THE SITE AND COMPACT THE SUBGRADE. 2. COVER THE AREA WITH NEEDLE-PUNCHED GEOTEXTILE.
- CONSTRUCT A 200mm THICK PAD OVER THE GEOTEXTILE USING ROAD BASE OR 30mm AGGREGATE.
- 4. ENSURE THE STRUCTURE IS AT LEAST 15 METRES LONG OR TO BUILDING ALIGNMENT AND AT LEAST 3 METRES WIDE.
- 5. WHERE A SEDIMENT FENCE JOINS ONTO THE STABILISED ACCESS, CONSTRUCT A HUMP IN THE STABILISED ACCESS TO DIVERT WATER TO THE SEDIMENT FENCE.

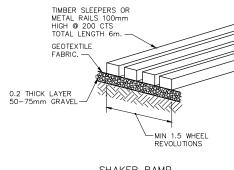

SHAKER RAMP

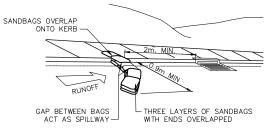

SANDBAG KERB INLET SEDIMENT TRAP

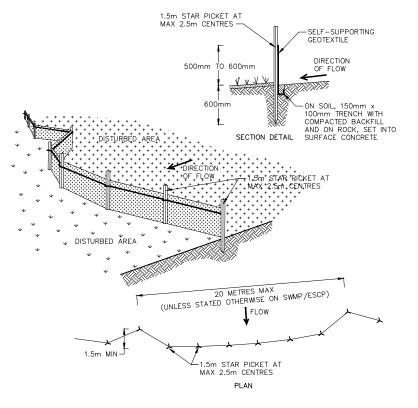

SEDIMENT FENCE (SD6-8) N.T.S.


- INSTRUCTION NOTES:

 CONSTRUCT SEDIMENT FENCES AS CLOSE AS POSSIBLE TO BEING PARALLEL TO THE CONTOURS

 OF THE SITE, BUT WITH SMALL RETURNS AS SHOWN IN THE DRAWING TO LIMIT THE CATCHMENT

 AREA OF ANY ONE SECTION. THE CATCHMENT AREA SHOULD BE SMALL ENOUGH TO LIMIT WATER
 FLOW IF CONCENTRATED AT ONE POINT TO 50 LITRES PER SECOND IN THE DESIGN STORM EVENT,


 USUALLY THE 10-YEAR EVENT.
- 2. CUT A 150mm DEEP TRENCH ALONG THE UPSLOPE LINE OF THE FENCE FOR THE BOTTOM OF THE FABRIC TO BE ENTRENCHED.
- 3. DRIVE 1.5m LONG STAR PICKETS INTO GROUND AT 2.5 METRE INTERVALS (MAX) AT DOWNSLOPE EDGE OF THE TRENCH. ENSURE ANY STAR PICKETS ARE FITTED WITH SAFETY CAPS.
- 4. FIX SELF-SUPPORTING GEOTEXTILE TO THE UPSLOPE SIDE OF THE POSTS ENSURING IT GOES TO THE BASE OF THE TRENCH. FIX THE GEOTEXTILE WITH WIRE TIES OR AS RECOMMENDED BY THE MANUFACTURER. ONLY USE GEOTEXTILE SPECIFICALLY PRODUCED FOR SEDIMENT FENCING. THE USE OF SHADE CLOTH FOR THIS PURPOSE IS NOT SATISFACTORY.
- 5. JOIN SECTIONS OF FABRIC AT A SUPPORT POST WITH A 150mm OVERLAP.
- 6. BACKFILL THE TRENCH OVER THE BASE OF THE FABRIC AND COMPACT IT THOROUGHLY OVER THE GEOTEXTILE.

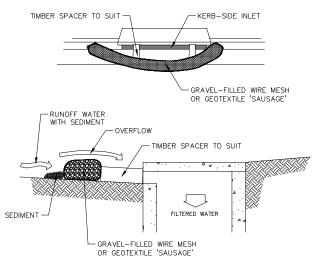

NOTE: THIS PRACTICE ONLY TO BE USED WHERE SPECIFIED IN AN APPROVED SWMP/ESCP.

MESH AND GRAVEL INLET FILTER (SD6-11)

- CONSTRUCTION NOTES:
 1. INSTALL FILTERS TO KERB INLETS ONLY ONLY AT SAG POINTS.
- 2. FABRICATE A SLEEVE MADE FROM GEOTEXTILE OR WIRE MESH LONGER THAN THE LENGTH OF THE INLET PIT AND FILL IT WITH 25mm TO 50mm GRAVEL.
- 3. FORM AN ELLIPTICAL CROSS SECTION ABOUT 150mm HIGH x 400mm WIDE.
- 4. PLACE THE FILTER AT THE OPENING LEAVING AT LEAST A 100mm SPACE BETWEEN IT AND THE KERB INLET. MAINTAIN THE OPENING WITH SPACER BLOCKS.
- 5. FORM A SEAL WITH THE KERB TO PREVENT SEDIMENT BYPASSING THE FILTER.
- 6. SANDBAGS FILLED WITH GRAVEL CAN SUBSTITUTE FOR THE MESH OR GEOTEXTILE PROVIDING THEY ARE PLACED SO THAT THEY FIRMLY ABUT EACH OTHER AND SEDIMENT-LADEN WATERS CANNOT PASS BETWEEN.

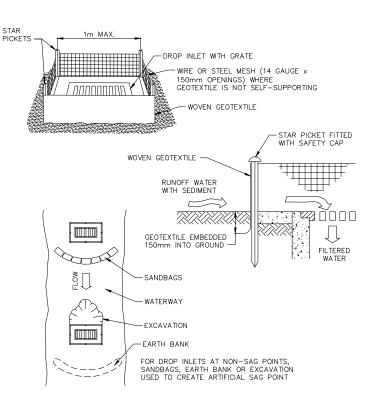

GEOTEXTILE INLET FILTER (SD6-12)

- CONSTRUCTION NOTES:
 1. FABRICATE A SEDIMENT BARRIER MADE FROM GEOTEXTILE OR STRAW BALES.
- 2. REFER STANDARD DRAWINGS 6-7 & 6-8 FOR INSTALLATION PROCEDURES FOR THE STRAW BALES OR GEOFABRIC. REDUCE THE PICKET SPACING TO 1 METRE CENTRES.
- 3. IN WATERWAYS, ARTIFICIAL SAG POINTS CAN BE CREATED WITH SANDBAGS OR EARTH BANKS AS SHOWN IN THE DRAWING.
- 4. DO NOT COVER THE INLET WITH GEOTEXTILE UNLESS THE DESIGN IS ADEQUATE TO ALLOW FOR ALL WATERS TO BYPASS IT.



NOT FOR CONSTRUCTION

REV. DATE AMENDMENT SCALES CLIENT PROPERTY DESCRIPTION PROJECT AMENDIMENT
NITIAL ISSUE
GENERAL AMENDMENTS
BIN STORAGE LOCATION AMENDED
JPDATED ARCHITECTUAL LAYOUT
RAINWATER TANK LOCATION AMENDED
JPDATED ARCHITECTURAL LAYOUT
AND ARCHITECTURAL LAYOUT
AND ARCHITECTURAL LAYOUT Central Coast PROPOSED ANIMAL SHELTER 5 Pioneer Avenue P.O. Box 3717, Tuggerah N.S.W. 2259 LOT 100. D.P.602992 NOT TO SCALE PLAN TITLE Central OLD MAITLAND ROAD, MARDI **EROSION & SEDIMENT CONTROL DETAILS** Coast Phone: (02) 4305 4300 adw (02) 4305 4399 Fax: Council email: coast@adwjohnson.co FEV. GDA2020 M.G.A. ZONE 56 A.H.D 190872 CENG DESIGN FILE S: \190872\DESIGN\12D\ANIMAL CARE FACILITY.project ALL DIMENSIONS ARE IN METRES. DO NOT SCA

